NORI RESIDENCE PROPOSED ALTERATIONS + ADDITIONS



	DRAWING LIST	
DRAWING NO.	DRAWING NAME	ISSUE DATE
A000	COVER	08/11/2023
A010	SITE PLAN	08/11/2023
A011	FLOOR PLAN (EXISTING)	08/11/2023
A012	FLOOR PLAN (EXISTING)	08/11/2023
A030	ELEVATIONS (EXISTING)	08/11/2023
A100	SITE PLAN (PROPOSED)	08/11/2023
A101	GROUND FLOOR PLAN (PROPOSED)	08/11/2023
A102	FLOOR PLAN (PROPOSED)	08/11/2023
A110	SLAB SETOUT PLAN	08/11/2023
A200	GROUND FLOOR CEILING PLAN (PROPOSED)	08/11/2023
A300	ELEVATION (PROPOSED)	08/11/2023
A301	ELEVATION (PROPOSED)	08/11/2023
A302	ELEVATION (PROPOSED)	08/11/2023
A400	SECTION	08/11/2023
A401	SECTION	08/11/2023
A500	DETAIL	08/11/2023
A501	DETAIL	08/11/2023
A600	INTERNAL ELEVATION	08/11/2023
A601	INTERNAL ELEVATION	08/11/2023
A700	SCHEDULE	08/11/2023
A900	EXISTING BUILDING FLOOR PLAN	08/11/2023

ALL BUILIDNG WORKS SHALL BE IN ACCORDANCE WITH APPLICABLE LOCAL AUTHORITY, BCA, AUSTRALIAN STANDARD AND ALL OTHER STATUTORY REQUIREMENTS.

ALL BUILDING WORKS SHALL COMPLY BUT NOT LIMITED TO THE FOLLOWING BUILDING CODE OF AUSTRALIA HOUSING PROVISIONS

SITE PREPARATION PART 3.1

PART 3.1.1 EARTHWORKS

PART 3.1.2 DRAINAGE

PART 3.1.3 TERMITE RISK MANAGEMENT

PART 3.2 FOOTINGS & SLABS

PART 3.2.2 PREPARATION

PART 3.2.3 CONCRETE & REINFORCING

PART 3.2.4 SITE CLASSIFICATION PART 3.2.5 FOOTINGS & SLAB

CONSTRUCTION

MASONRY

PART 3.3.1 UNREINFORCED MASONRY

PART 3.3.2 REINFORCED MASONRY PART 3.3.3 MASONRY ACCESSORIES

PART 3.3.4 WEATHERPROOFING OF MASONRY

PART 3.4 FRAMING

PART 3.4.1 SUB-FLOOR VENTILATION PART 3.4.2 STEEL FRAMING

PART 3.4.3 TIMBER FRAMING

PART 3.4.4 STRUCTURAL STEEL MEMBERS

ROOF & WALL CLADDING

PART 3.5.1 ROOF CLADDING

PART 3.5.2 GUTTERS & DOWNPIPES

PART 3.5.3 WALL CLADDING

PART 3.6z GLAZING

PART 3.7 FIRE SAFETY

PART 3.7.1 FIRE SEPARATION PART 3.7.2 SMOKE ALARMS

PART 3.7.3 HEATING APPLIANCES

PART 3.8 **HEALTH & AMENITY**

PART 3.8.1 WET AREAS

PART 3.8.2 ROOM HEIGHTS

PART 3.8.3 FACILITIES

PART 3.8.4 LIGHT PART 3.8.5 VENTILIATION

PART 3.9.2 BALUSTRADES

AUSTRALIAN STANDARDS

AS 1288 & 2208 GLASS IN BUILDINGS

AS 1684 NATIONAL TIMBER FRAMING CODE NATIONAL PLUMBING & DRAINAGE CODE PROTECTION OF BUILDINGS FROM TERMITES AS 3500.3

AS 3660.1

AS 3786 SMOKE ALARMS

AS 3958 CERAMIC TILES ELECTRICAL INSTALLATION AS 3000

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NOTE:

CLIENT:

ANNAPURNA NORI

PROJECT ADDRESS:

14 PALMERSTON RD, UNLEY SA 5061

COVER


FOR APPROVAL NOT FOR CONSTRUCTION

21011 Project number Date 16.11.2023 Drawn by CM Checked by

A000

1:1

Scale

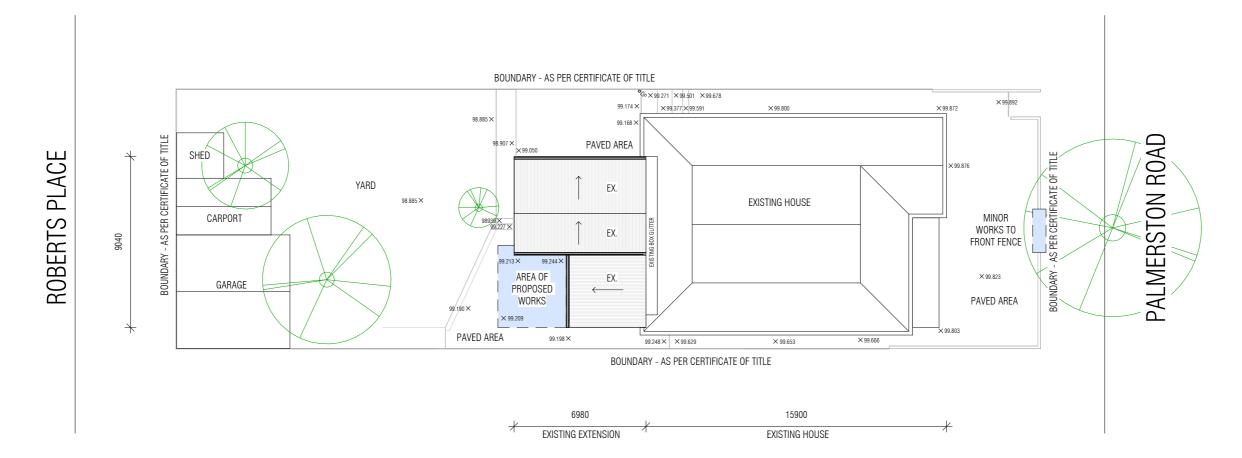

1 EXISTING SITE PLAN 1:200



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NOTE:

- BUILDERS TO ALLOW FOR TEMPORARY PROPPING ENGINEERING AS REQUIRED TO ENSURE EXISTING STRUCTURE IS SUITABLY SUPPORTED DURING WORKS.
- PROTECT EXISTING BUILDING DURING ALL DEMOLITION WORKS
- MAKE GOOD & RECTIFY ANY DAMAGES

CLIENT:

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PROJECT ADDRESS:


14 PALMERSTON RD, UNLEY SA 5061

SITE PLAN

FOR APPROVAL NOT FOR CONSTRUCTION

Project number	21011
Date	16.11.2023
Drawn by	СМ
Checked by	CM

A010

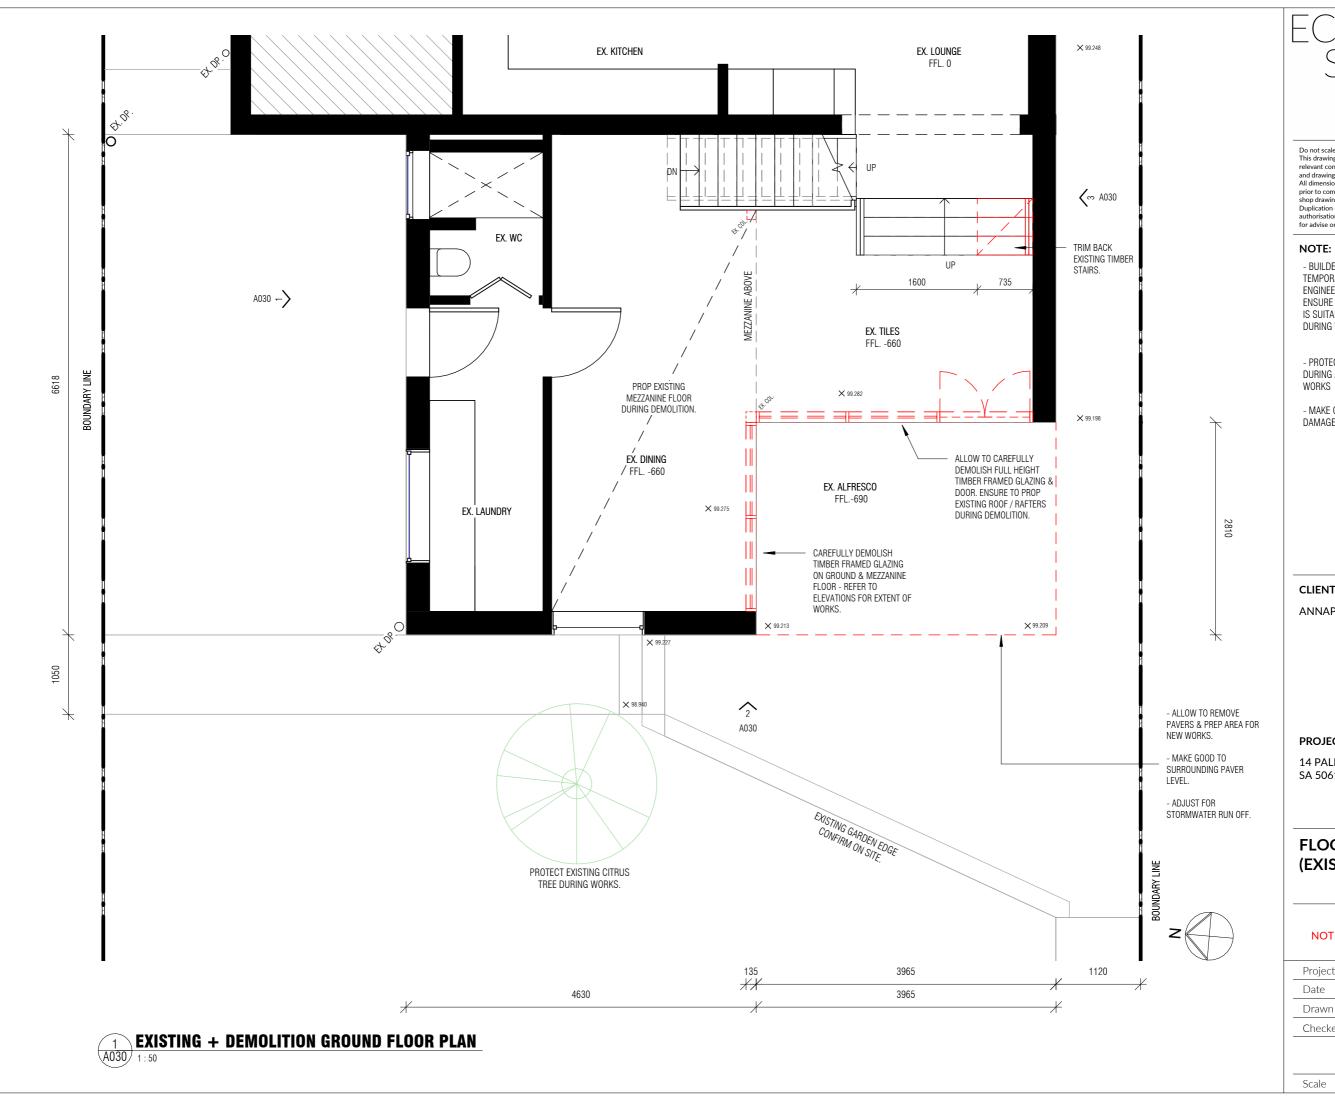

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- MAKE GOOD & RECTIFY ANY DAMAGES

CLIENT:

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PROJECT ADDRESS:


14 PALMERSTON RD, UNLEY SA 5061

FLOOR PLAN (EXISTING)

FOR APPROVAL NOT FOR CONSTRUCTION

Project number	21011
Date	16.11.2023
Drawn by	CM
Checked by	CM

A011

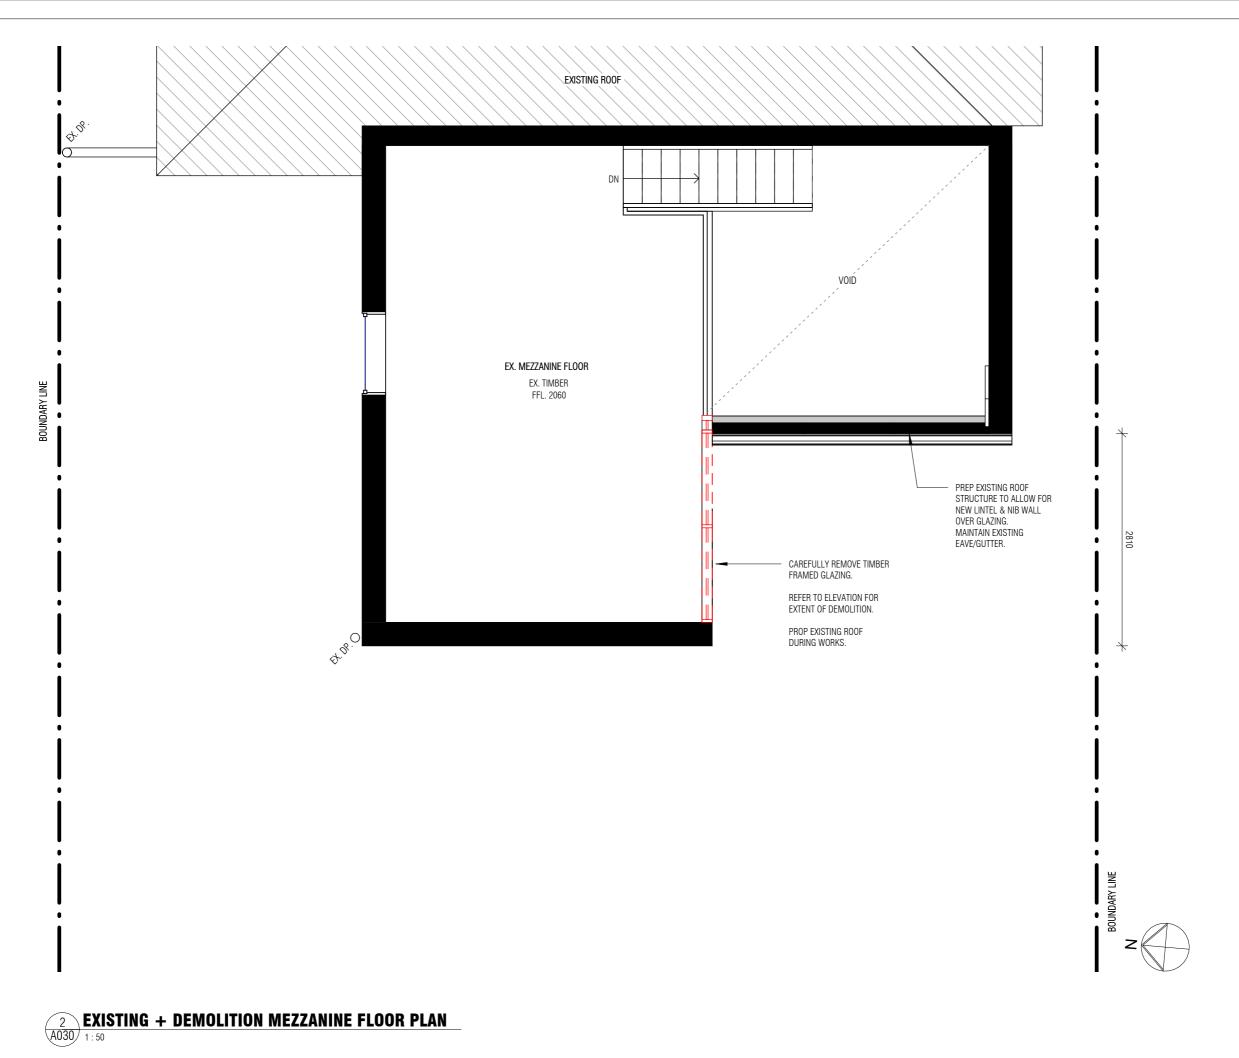

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CLIENT:

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PROJECT ADDRESS:


14 PALMERSTON RD, UNLEY SA 5061

FLOOR PLAN (EXISTING)

FOR APPROVAL NOT FOR CONSTRUCTION

Project number	21011
Date	16.11.2023
Drawn by	CM
Checked by	CM
• • •	

A012

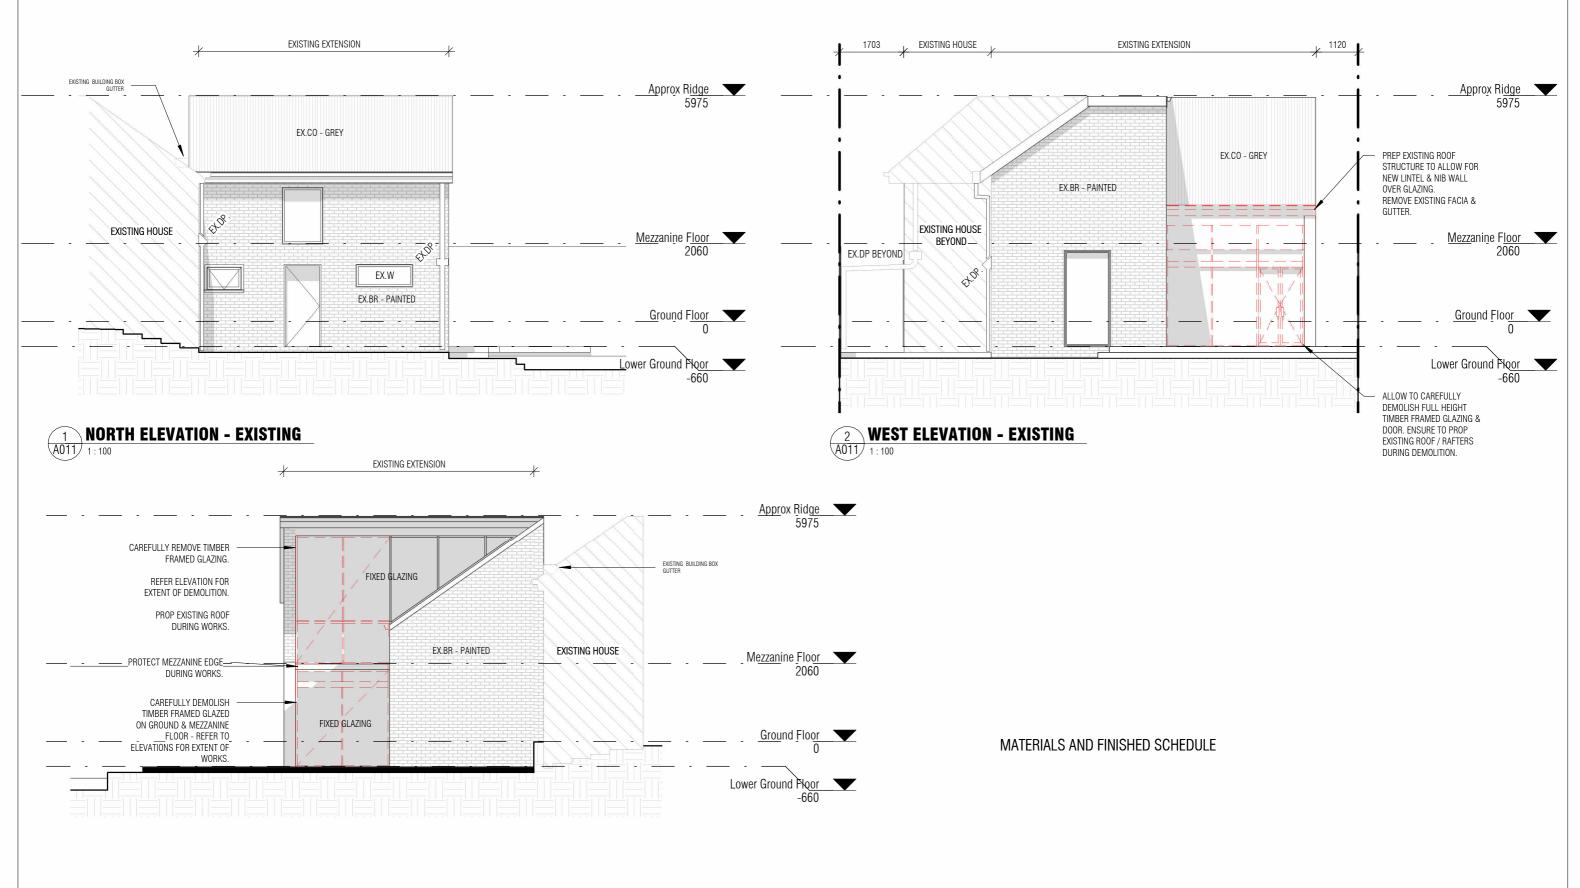

3 SOUTH ELEVATION - EXISTING

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OTE: - BUILDERS TO ALLOW FOR TEMPORARY PROPPING ENGINEERING AS REQUIRED TO ENSURE EXISTING STRUCTURE IS SUITABLY SUPPORTED DURING WORKS.


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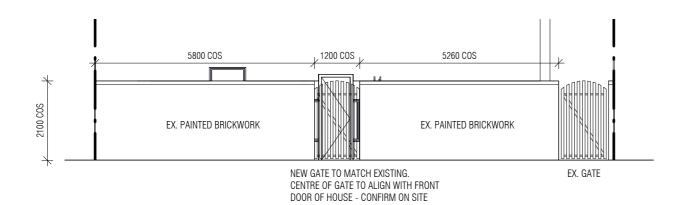
ELEVATIONS (EXISTING)

FOR APPROVAL NOT FOR CONSTRUCTION

Project number	21011
Date	16.11.2023
Drawn by	CM
Checked by	СМ
A03	80
Scale	1 · 100





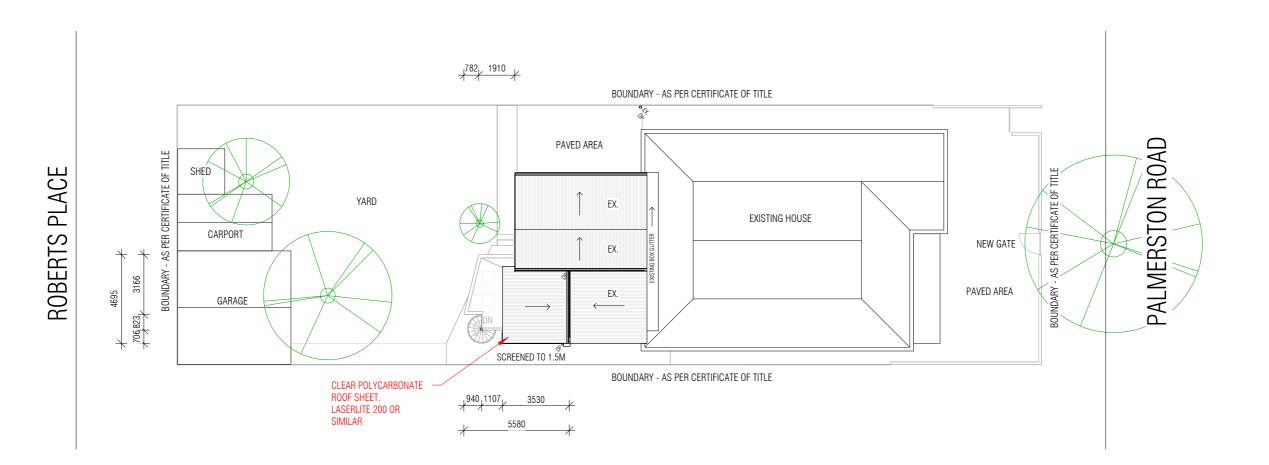

PROPOSED FRONT FENCE ALTERATIONS

1:100

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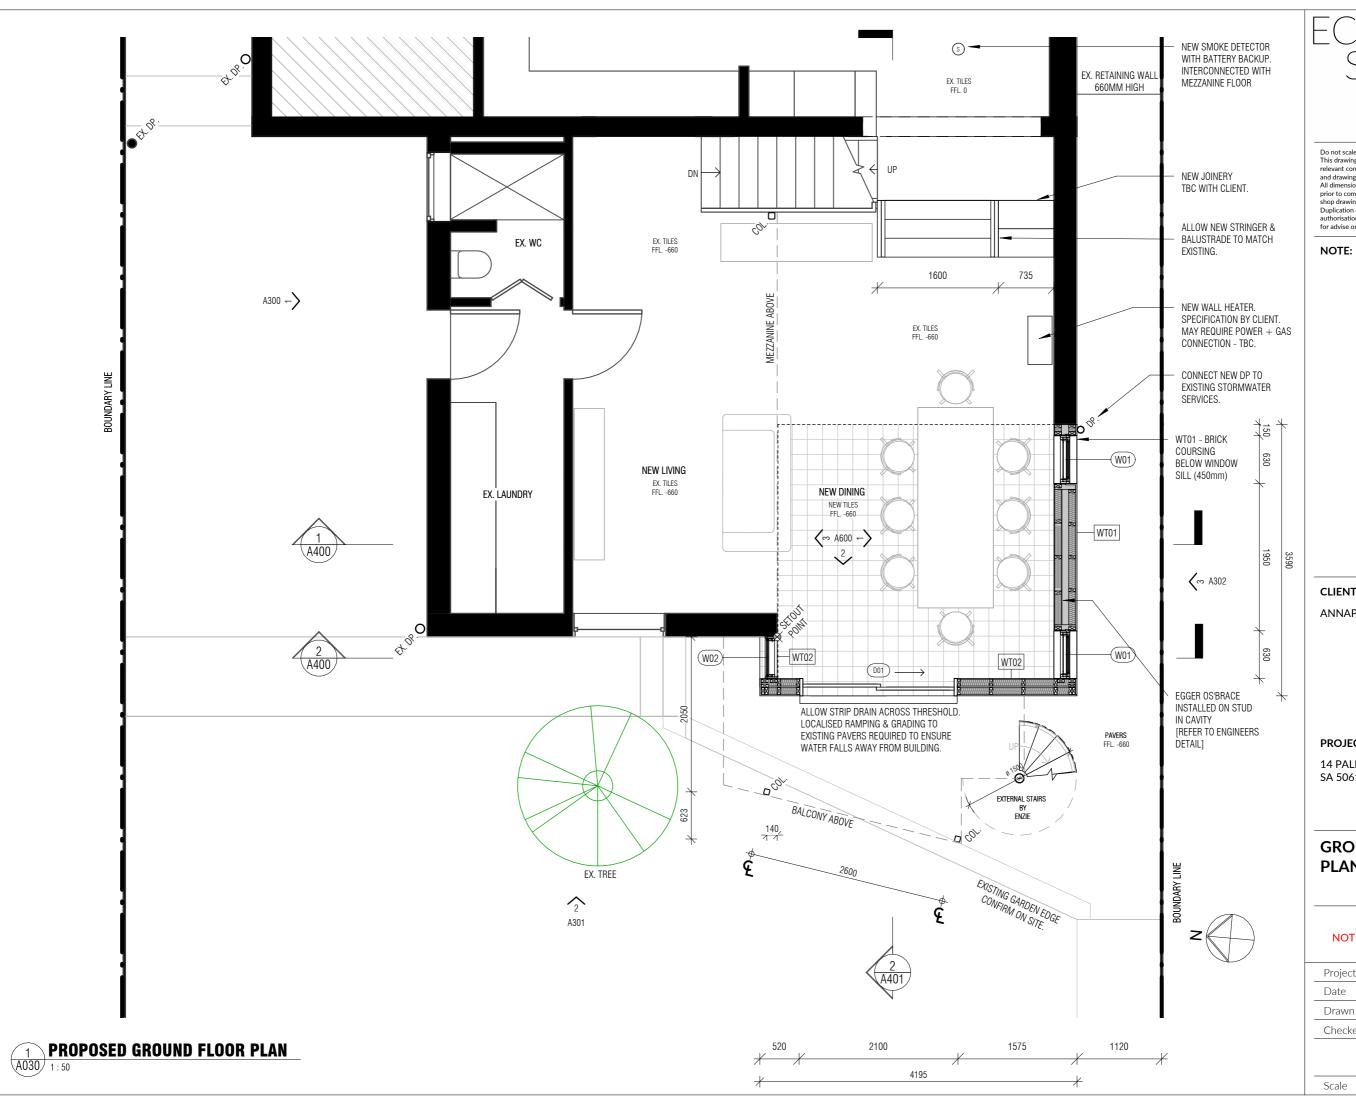
SITE PLAN (PROPOSED)

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Project number	21011
Date	16.11.2023
Drawn by	CM
Checked by	СМ

A100

Scale As indicated



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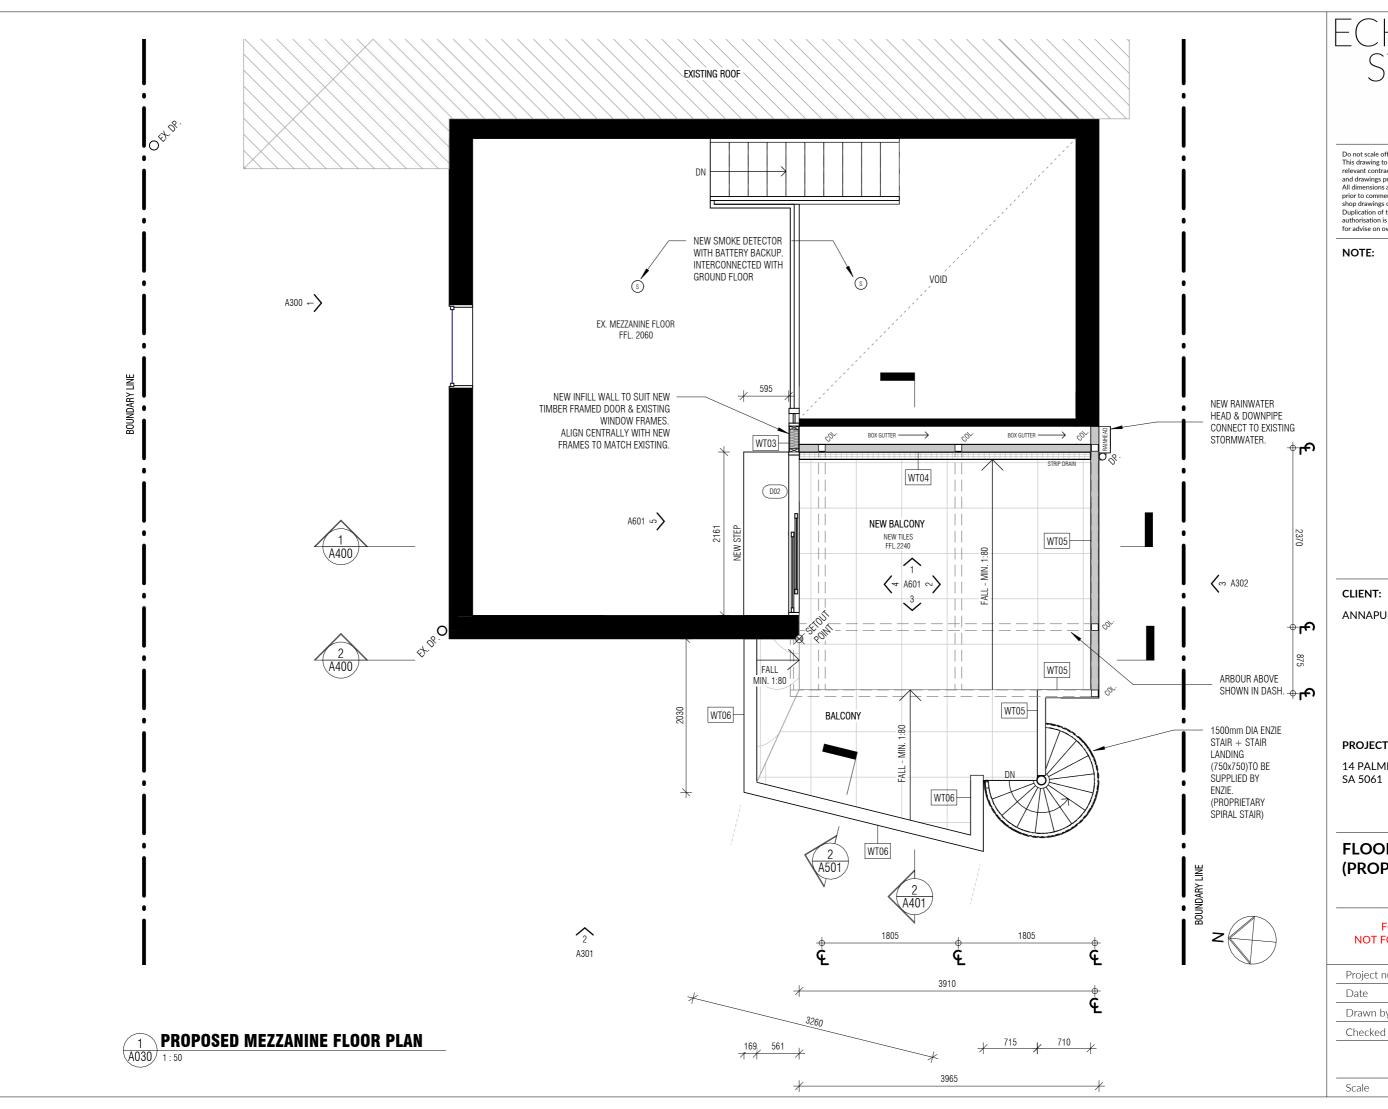
14 PALMERSTON RD, UNLEY SA 5061

GROUND FLOOR PLAN (PROPOSED)

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Checked by	CM
Drawn by	СМ
Date	16.11.2023
Project number	21011

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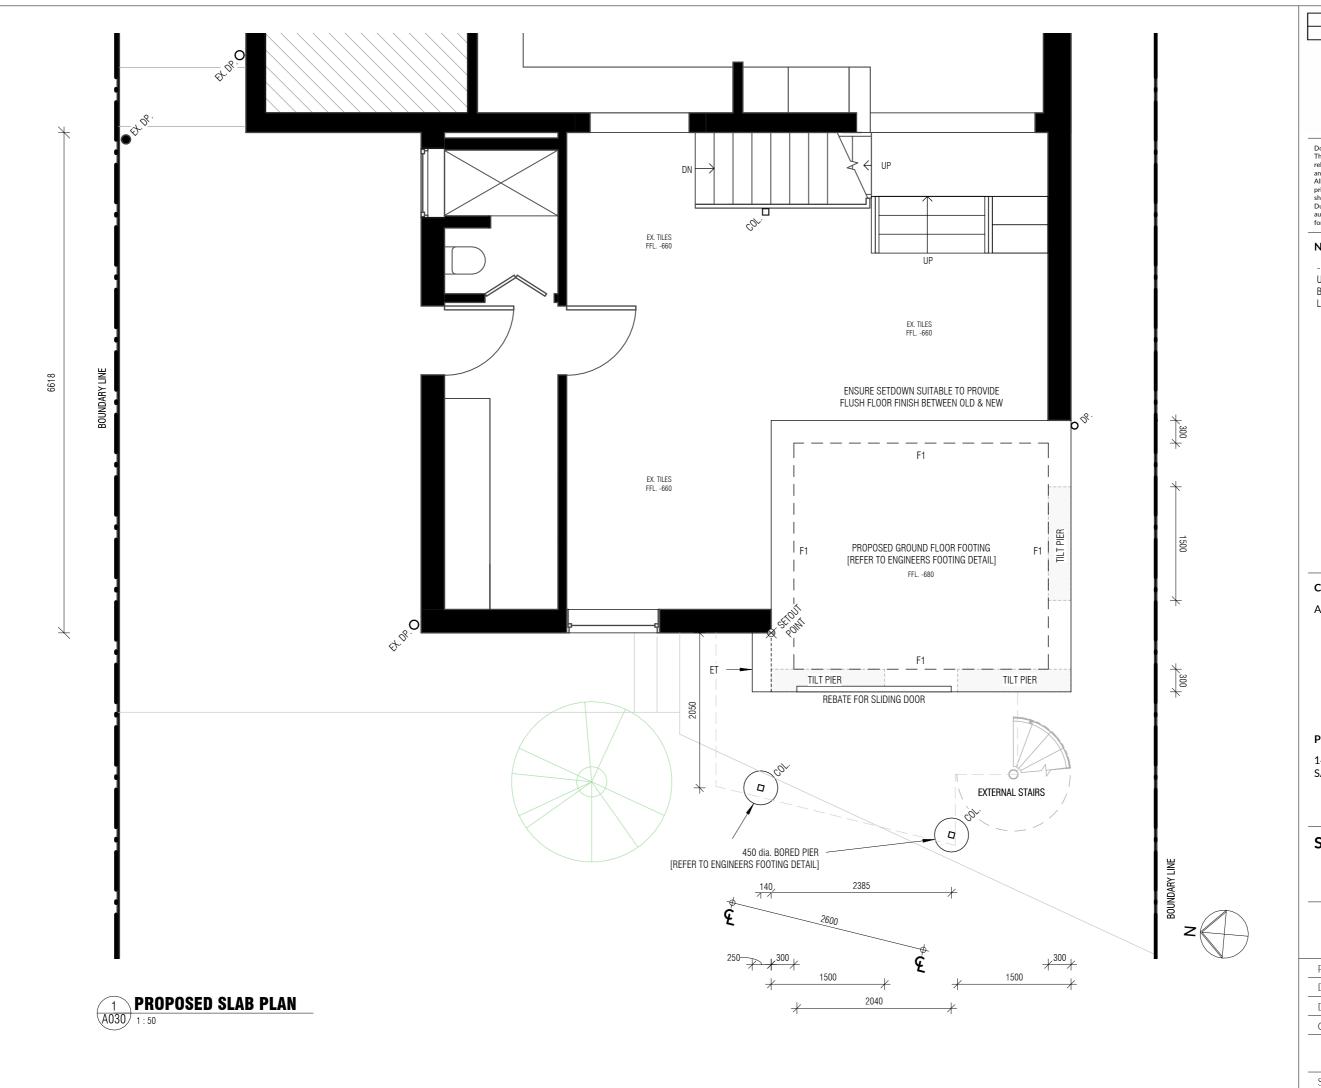
FLOOR PLAN (PROPOSED)

> FOR APPROVAL NOT FOR CONSTRUCTION

Project number	21011
Date	16.11.2023
Drawn by	CM
Checked by	CM
A 1 C	12

A102

1:50



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NOTE:

- REVIEW FOOTING PLAN FOR UPSTAND REQUIREMENTS BASED ON ADJACENT SURFACE LEVELS.

CLIENT:

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PROJECT ADDRESS:


14 PALMERSTON RD, UNLEY SA 5061

SLAB SETOUT PLAN

FOR APPROVAL NOT FOR CONSTRUCTION

Project number	21011
Date	16.11.2023
Drawn by	CM
Checked by	CM

A110

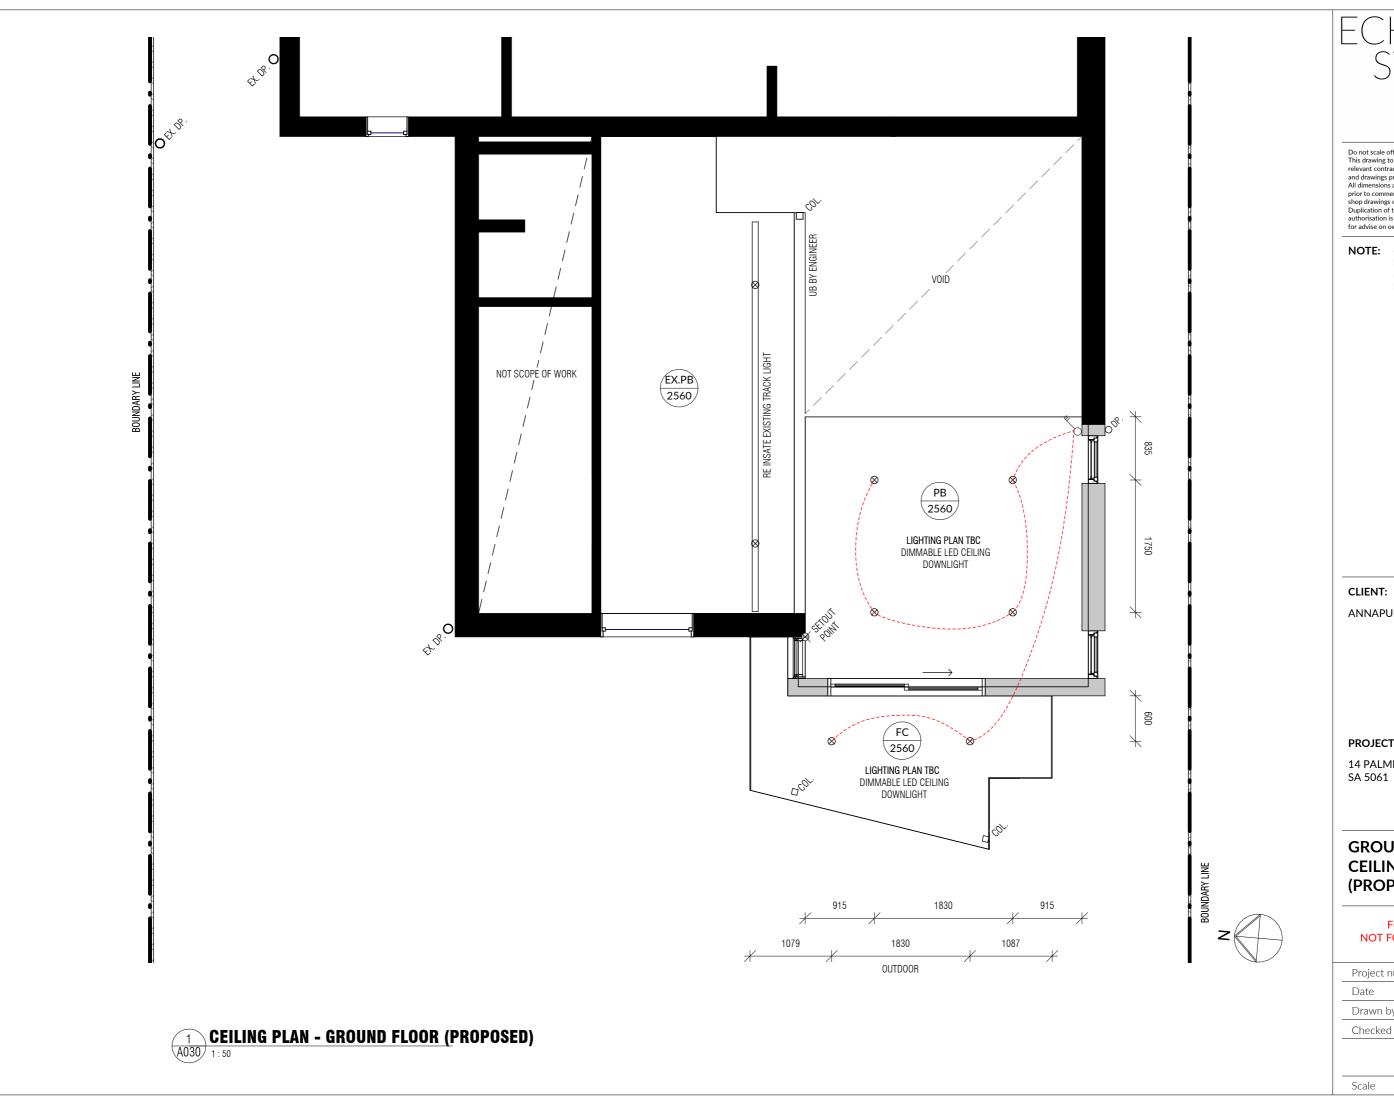

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NOTE: - CEILING LEVEL IS MEASURED FROM LOVER GROUND FL00R

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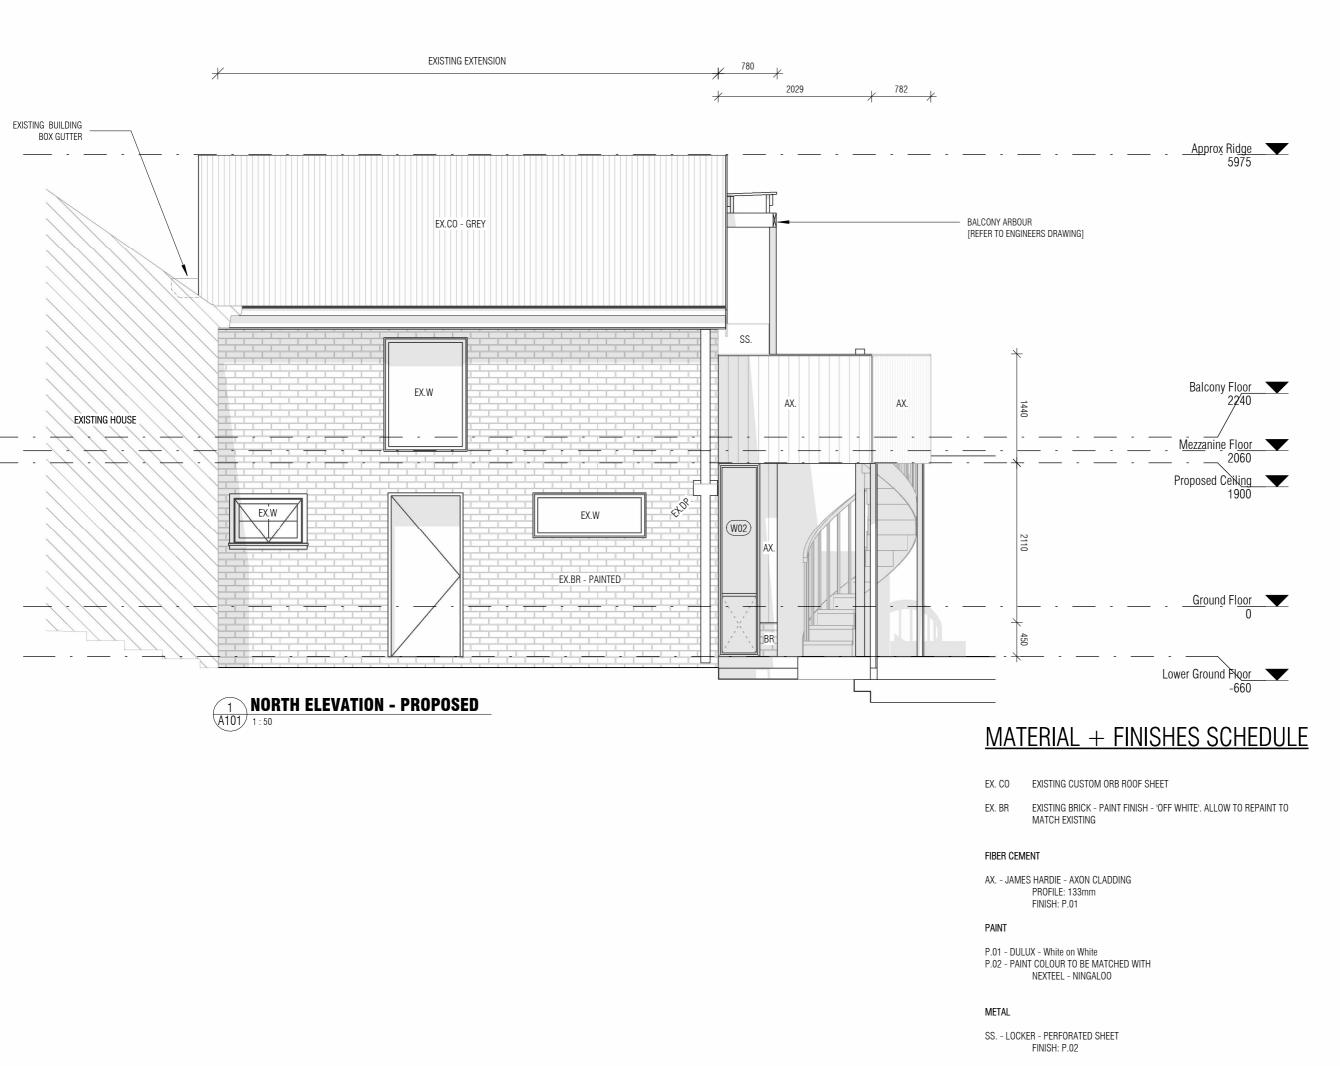
GROUND FLOOR CEILING PLAN (PROPOSED)

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Project number	21011
Date	16.11.2023
Drawn by	CM
Checked by	СМ

A200

1:50



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NOTE:

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PROJECT ADDRESS:

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ELEVATION (PROPOSED)

FOR APPROVAL NOT FOR CONSTRUCTION

Project number 21011


Date 16.11.2023

Drawn by CM

Checked by CM

A300

Scale As indicated

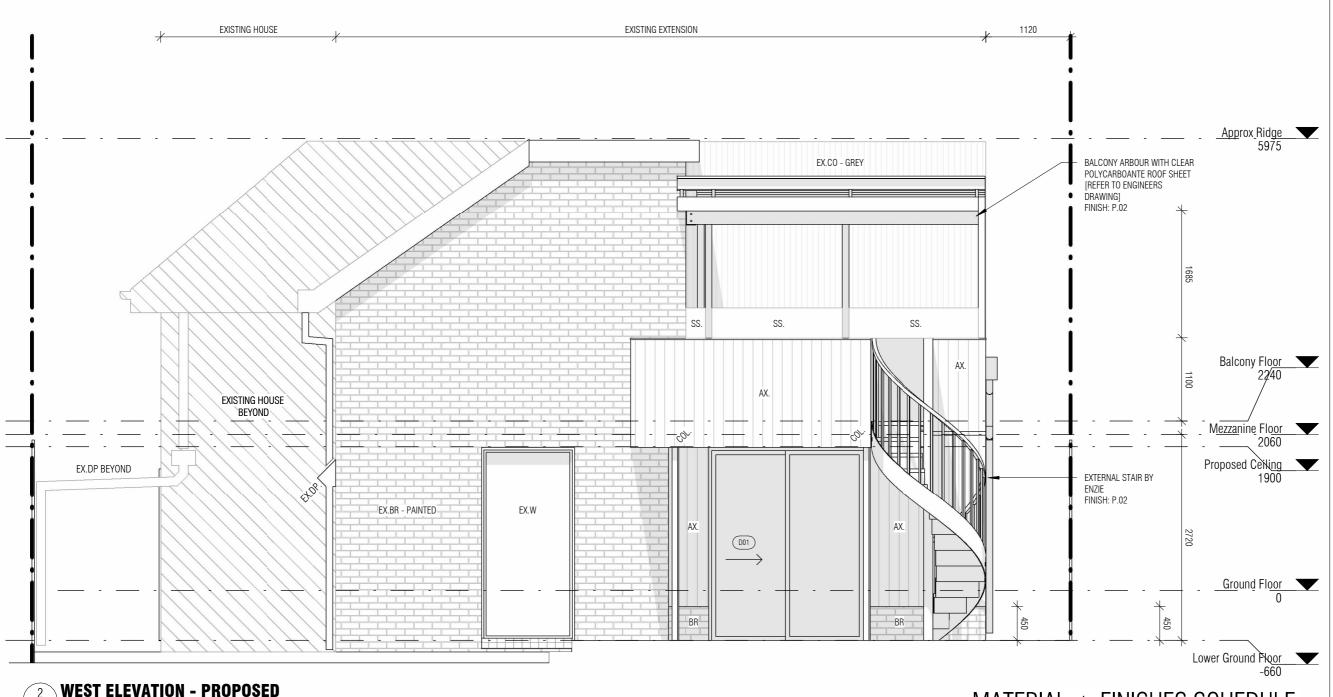

WEST ELEVATION - PROPOSED

MATERIAL + FINISHES SCHEDULE

EX. CO EXISTING CUSTOM ORB ROOF SHEET

EX. BR EXISTING BRICK - PAINT FINISH - 'OFF WHITE'. ALLOW TO REPAINT TO MATCH EXISTING

FIBER CEMENT

AX. - JAMES HARDIE - AXON CLADDING PROFILE: 133mm FINISH: P.01

PAINT

P.01 - DULUX - White on White P.02 - PAINT COLOUR TO BE MATCHED WITH NEXTEEL - NINGALOO

METAL

SS. - LOCKER - PERFORATED SHEET FINISH: P.02

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PROJECT ADDRESS:

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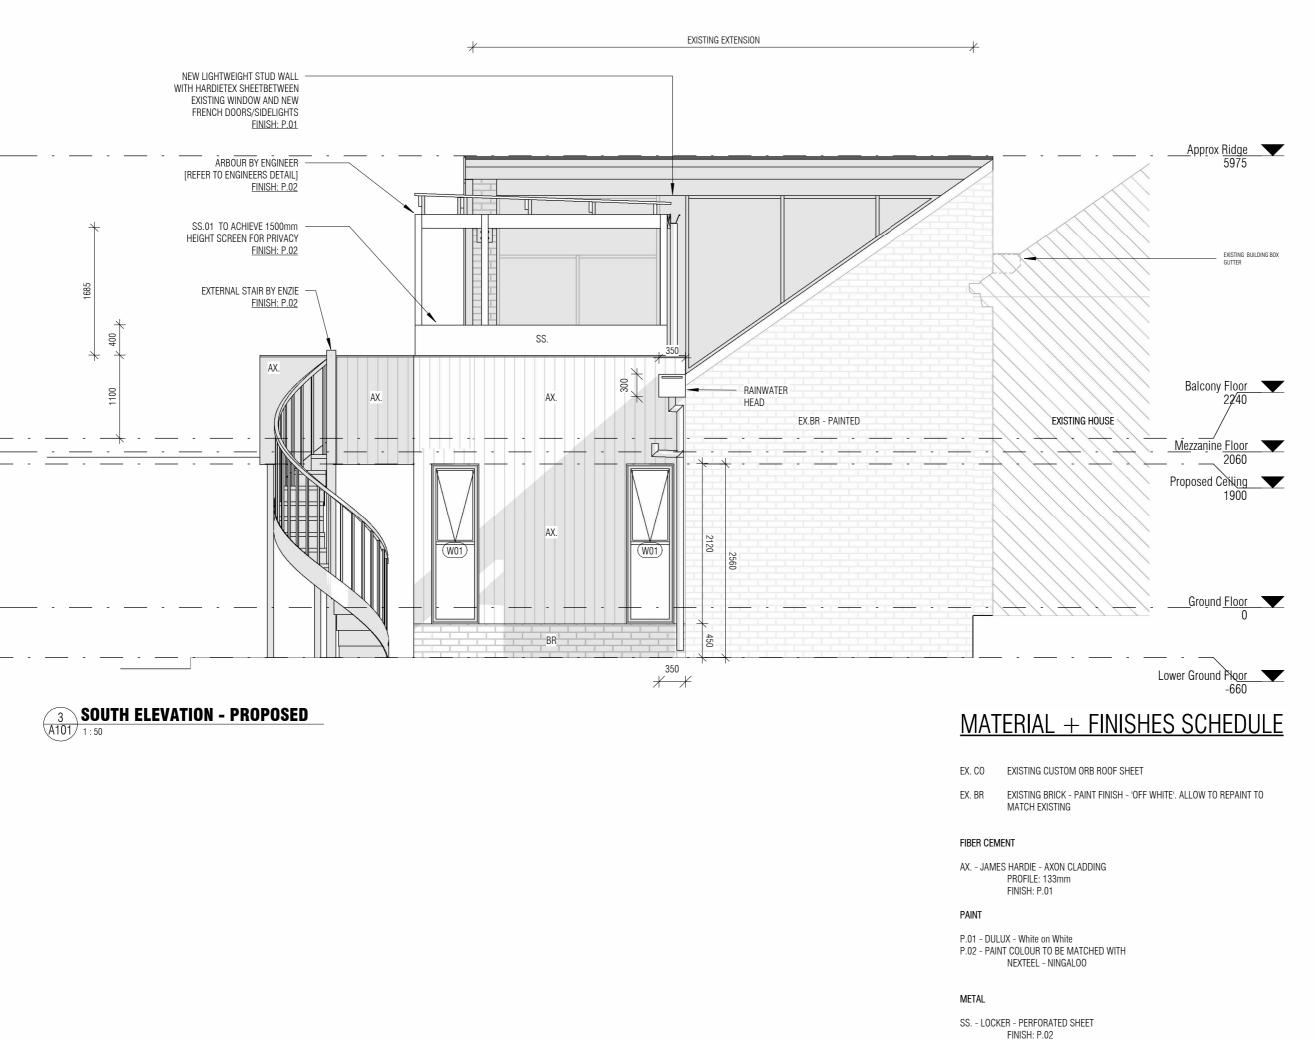
ELEVATION (PROPOSED)

> FOR APPROVAL NOT FOR CONSTRUCTION

21011 Project number Date 16.11.2023 Drawn by CM Checked by CM

A301

Scale As indicated



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NOTE:

CLIENT:

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PROJECT ADDRESS:

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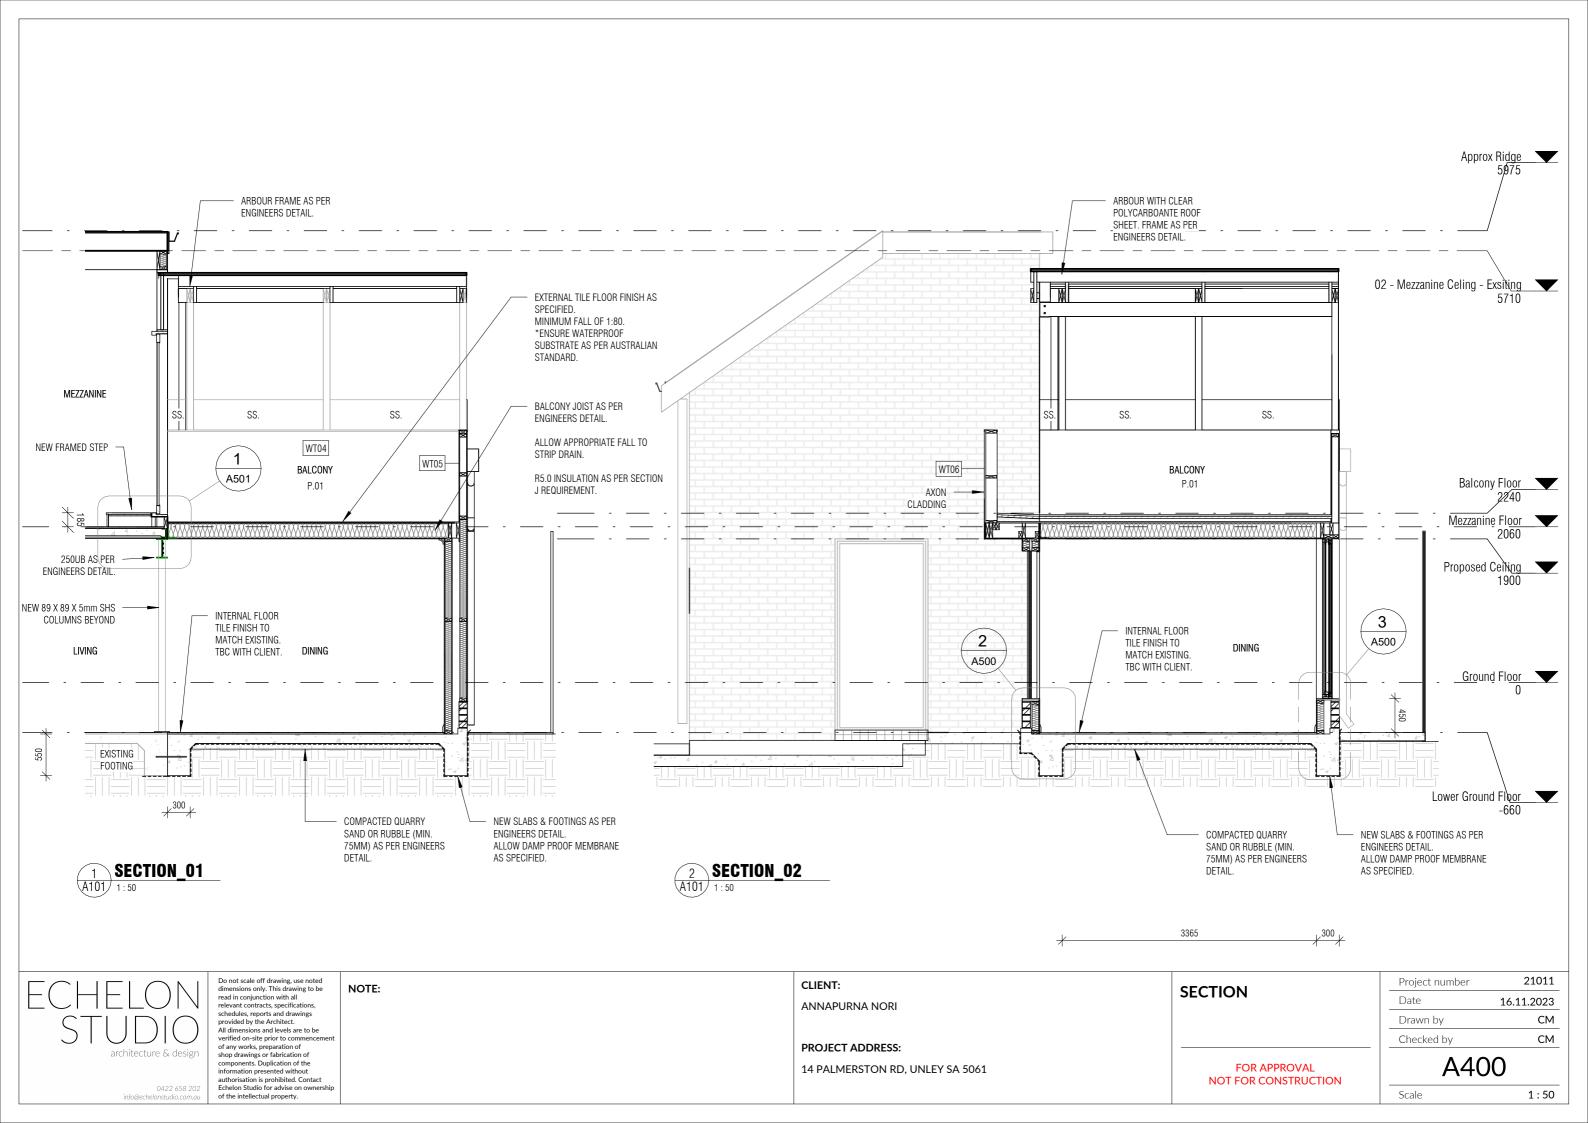
ELEVATION (PROPOSED)


FOR APPROVAL NOT FOR CONSTRUCTION

Project number	21011
Date	16.11.2023
Drawn by	СМ
Checked by	СМ

A302

Scale As indicated



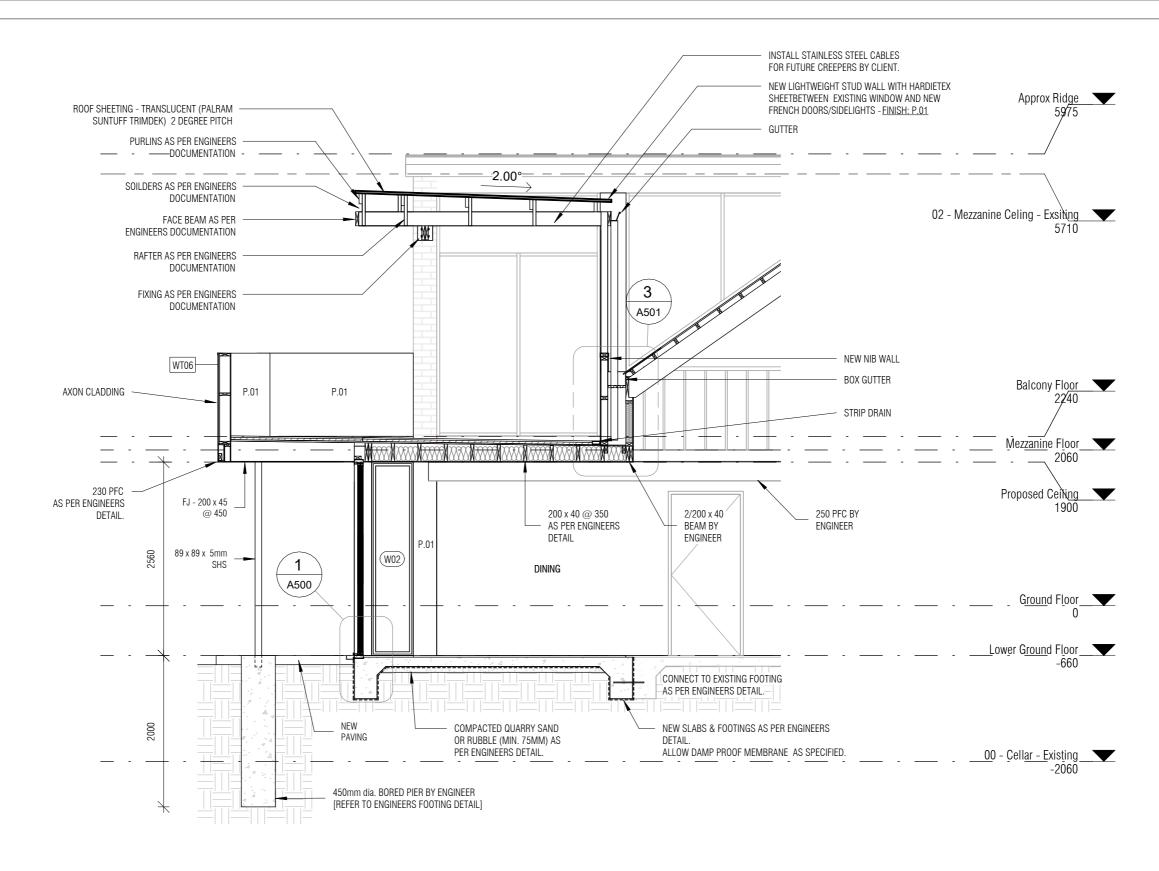



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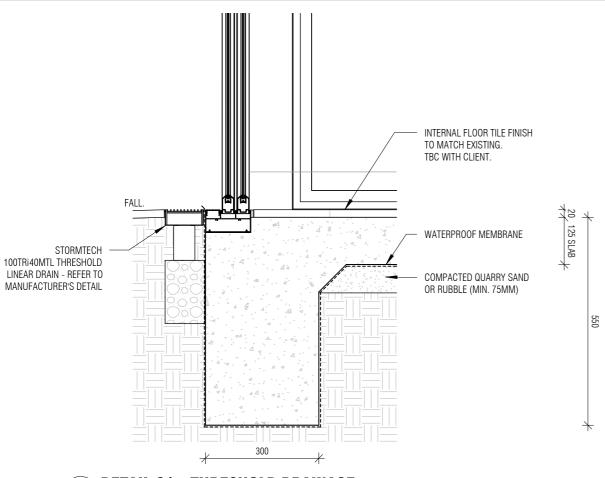
NOTE:

CLIENT: ANNAPURNA NORI


PROJECT ADDRESS: 14 PALMERSTON RD, UNLEY SA 5061 SECTION

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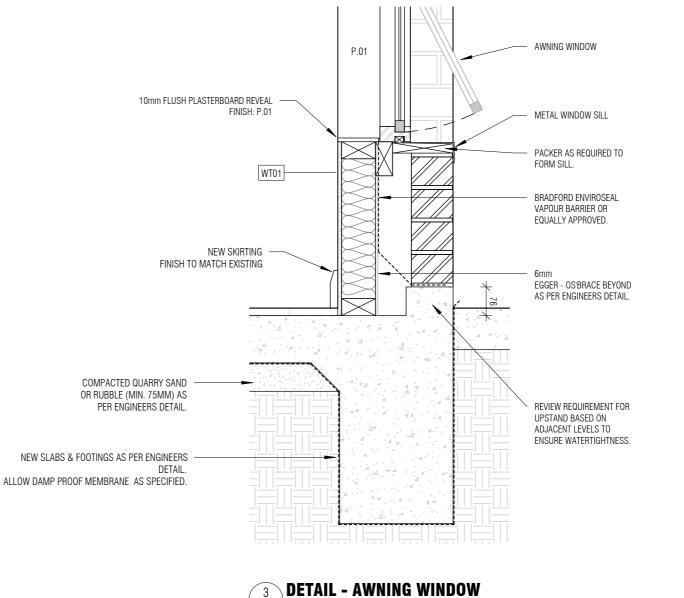
Project number	21011	
Date	16.11.2023	
Drawn by	CM	
Checked by	CM	
A401		



DETAIL 01 - THRESHOLD DRAINAGE 1 DET A401 1:10

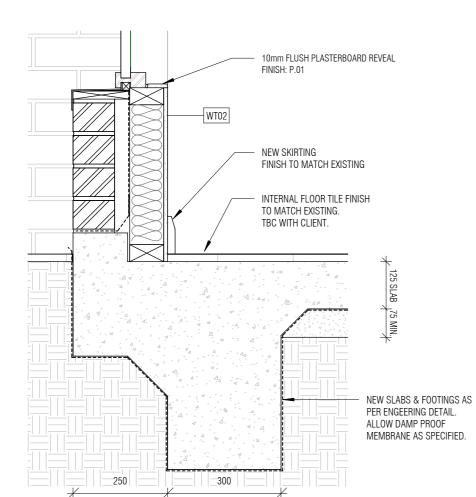

DETAIL 02 - EXTENDED FOOTING



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NOTE:

- REVIEW FOOTING PLAN FOR UPSTAND REQUIREMENTS BASED ON ADJACENT SURFACE LEVELS.

CLIENT:

ANNAPURNA NORI

PROJECT ADDRESS:


14 PALMERSTON RD, UNLEY SA 5061

DETAIL

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Λ500		
Checked by	СМ	
Drawn by	CM	
Date	16.11.2023	
Project number	21011	

ASUU

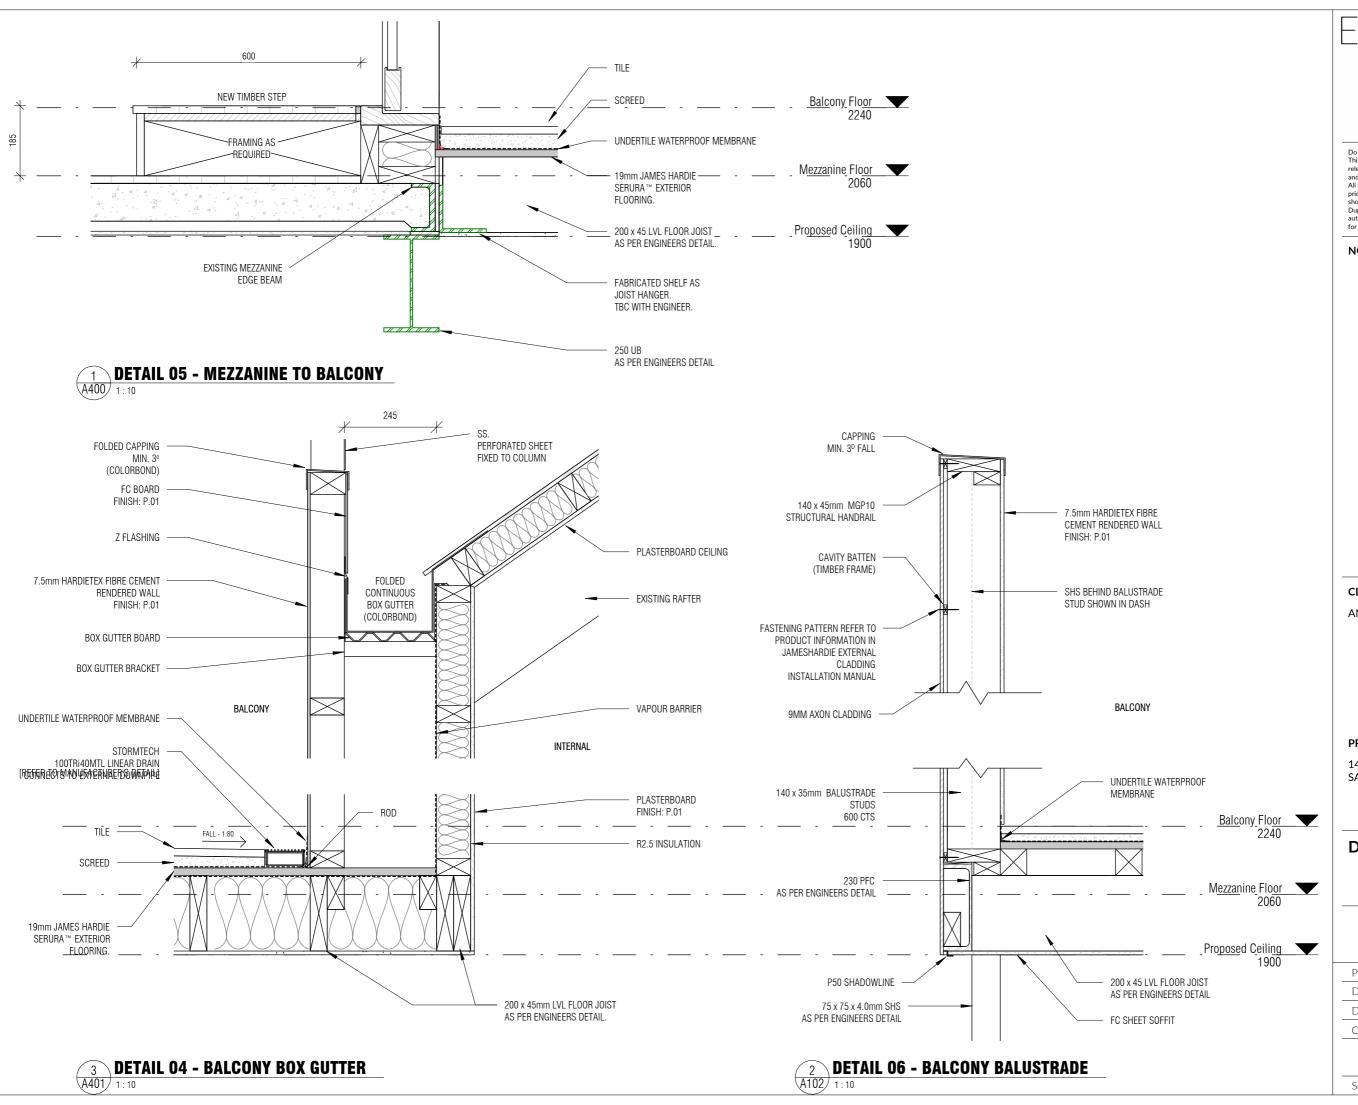

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NOTE:

CLIENT:

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PROJECT ADDRESS:


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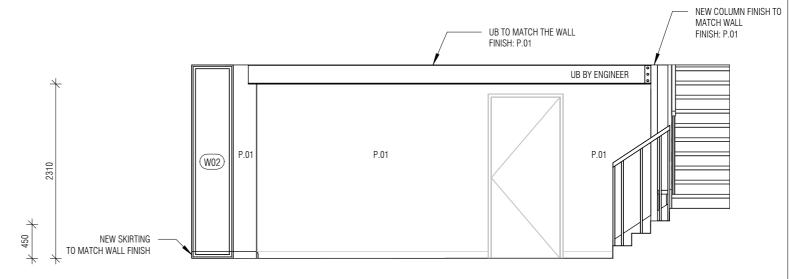
DETAIL

FOR APPROVAL NOT FOR CONSTRUCTION

Project number	21011
Date	16.11.2023
Drawn by	СМ
Checked by	СМ
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A501



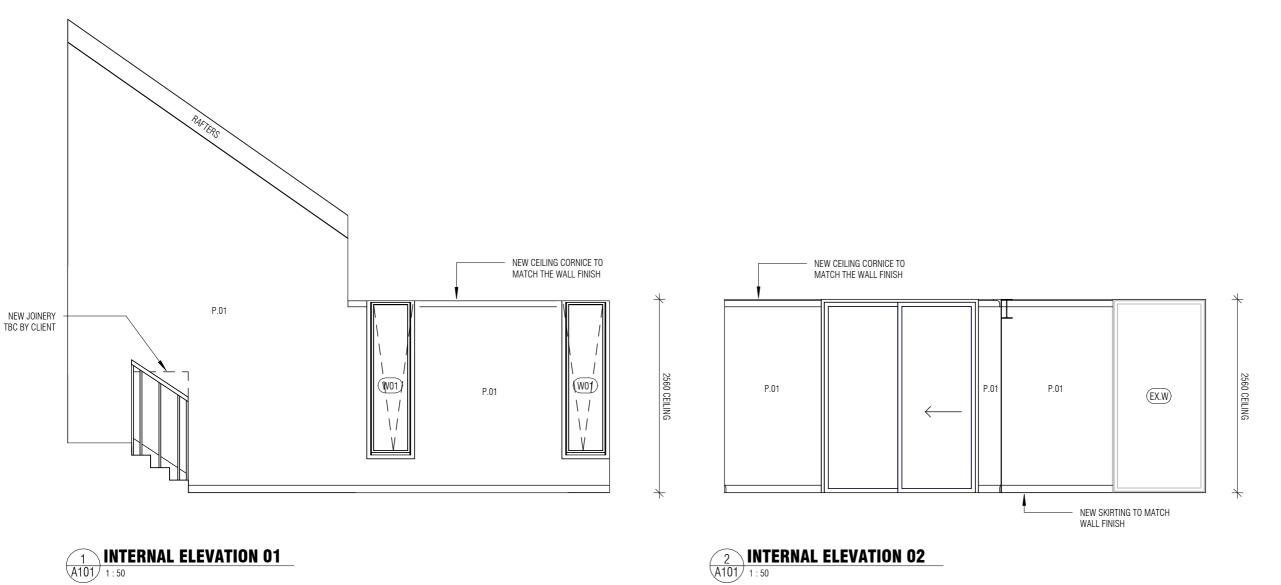

3 INTERNAL ELEVATION 03

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NOTE:

CLIENT:

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PROJECT ADDRESS:


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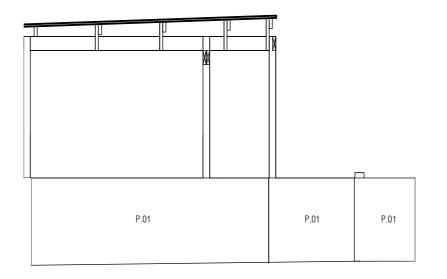
INTERNAL **ELEVATION**


FOR APPROVAL NOT FOR CONSTRUCTION

Project number	21011		
Date	16.11.2023		
Drawn by	CM		
Checked by	CM		
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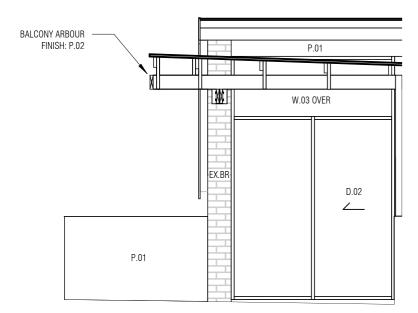





1 INTERNAL ELEVATION - BALCONY - 01 1:50

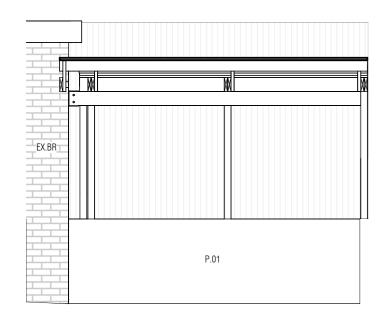INTERNAL ELEVATION - BALCONY - 02

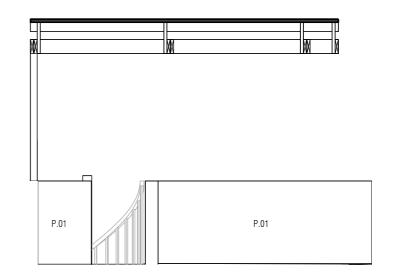INTERNAL ELEVATION - BALCONY - 03 3 INTI



1 INTERNAL ELEVATION - BALCONY - 04

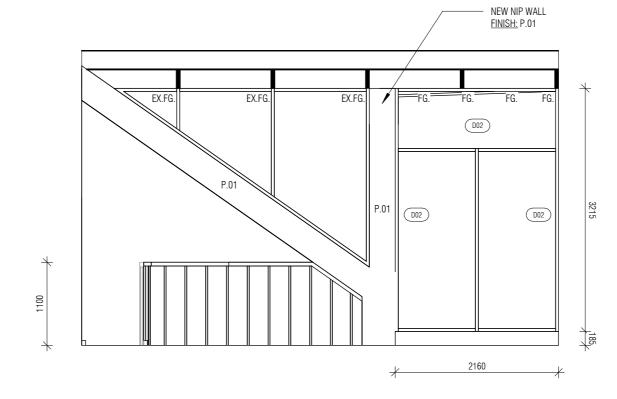

INTERNAL ELEVATION - MEZZANINE 5 INTI A102 1:50

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PROJECT ADDRESS:


14 PALMERSTON RD, UNLEY SA 5061

INTERNAL **ELEVATION**

> FOR APPROVAL NOT FOR CONSTRUCTION

A601	
Checked by	CM
Drawn by	CM
Date	16.11.2023
Project number	21011

<u>DOOR + WINDOW SCHEDULE</u>

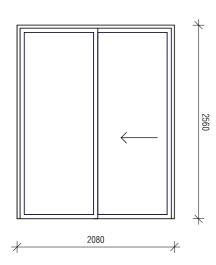


D01 Sliding Door

Frame material: Aluminium Finish: White powdercoat Glass option: Clear

Handle option: Architectural handle (White) Dimension: 2080w x 2560h mm Glazing Thickness: Double glazed

Supplier: Rylock


Location: Ground Floor

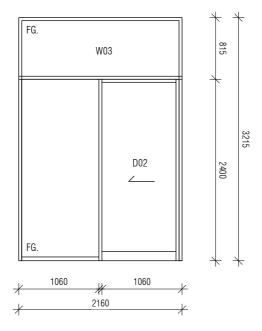

D02 External Sliding Door with Fixed Sidelight + W03 Fixed Glass Fanlight

Frame material: Aluminium Finish: White powdercoat Handle/Lockset: Aria handle (White) Dimension: 2160w x 2400h mm Supplier: Rylock

Location: Mezzanine Floor

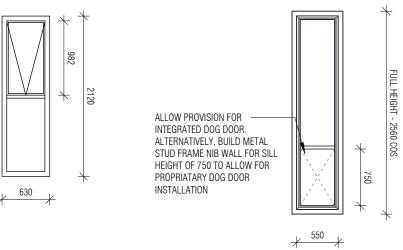

W01 Awning Window


Frame material: Aluminium Finish: White powdercoat Glass option: Clear

Handle option: Truthbar Operator (White) Dimension: 630w x 2120h - Half Height

Glazing Thickness: Double glazed

Supplier: Rylock

Location: Ground floor

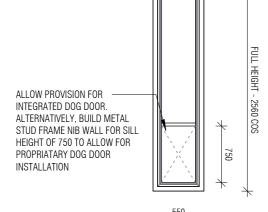

W02 Fixed Window

Frame material: Aluminium Finish: White powdercoat Glass option: Clear Dimension: 825w x 2560h Glazing Thickness: Double glazed

Supplier: Rylock

Location: Ground floor

MATERIAL + FINISHES SCHEDULE

EX. CO EXISTING CUSTOM ORB ROOF SHEET

EX. BR EXISTING BRICK - PAINT FINISH - 'OFF WHITE'. ALLOW TO REPAINT TO

FIBER CEMENT

AX. - JAMES HARDIE - AXON CLADDING PROFILE: 133mm FINISH: P.01

PAINT

P.01 - DULUX - White on White P.02 - PAINT COLOUR TO BE MATCHED WITH
NEXTEEL - NINGALOO

METAL

SS. - LOCKER - PERFORATED SHEET FINISH: P.02

WALL SCHEDULE

305mm TO MATCH EXISTING DOUBLE BRICK WALL

10 PB + 90 STUD + 95 CAVITY + 110 BRICK
*BRICK VENEER REVERT TO DOUBLE STUD FROM 450 ABOVE, TO; 10 PB + 90 STUD + CAVITY + 90 STUD + 9 AXON

FINISH: P.01 BOTH SIDE

230mm DOUBLE STUD WALL

10 PB + 90 STUD + 20 CAVITY + 110 BRICK

*BRICK VENEER REVERT TO DOUBLE STUD FROM 450 ABOVE, TO; 10 PB + 90 STUD + 30 CAVITY + 90 STUD + 9 AXON

FINISH: P.01 BOTH SIDE

140mm WALL

10 PB + 120 STUD + 7.5 HARDIETEX

FINISH: P.01 BOTH SIDE

102mm BALCONDY BALUSTRADE

7.5 HARDIETEX + 90 STUD + 4 FC BOARD

FINISH: P.01 BOTH SIDE

107mm BALCONDY BALUSTRADE

7.5 HARDIETEX + 90 STUD + 9 AXON

FINISH: P.01 BOTH SIDE

167mm BALCONDY BALUSTRADE

7.5 HARDIETEX + 140 STUD + 10 CAVITY BATTEN + 9 AXON

FINISH: P.01 BOTH SIDE

Do not scale off drawing, use noted dimensions only. This drawing to be read in conjunction with all relevant contracts, specifications, schedules, reports and drawings provided by the Architect.
All dimensions and levels are to be verified on-site
prior to commencement of any works, preparation of
shop drawings or fabrication of components. Duplication of the information presented without authorisation is prohibited. Contact Echelon Studio for advise on ownership of the intellectual property.

NOTE:

CLIENT:

ANNAPURNA NORI

PROJECT ADDRESS:

14 PALMERSTON RD, UNLEY SA 5061

SCHEDULE

FOR APPROVAL NOT FOR CONSTRUCTION

Project number	21011
Date	16.11.2023
Drawn by	CM
Checked by	СМ

A700

Scale As indicated